
4 INKERMAN ST, MOSMAN NSW 2088

LANDSCAPE WORKS DEVELOPMENT APPLICATION

DRAWING LIST

No.	TITLE
LA-000	Cover sheet
LA-100	Landscape plan
LA-101	Landscape plan
LA-200	Landscape details
LA-300	Planting schedule
LA-301	Planting schedule & reference images

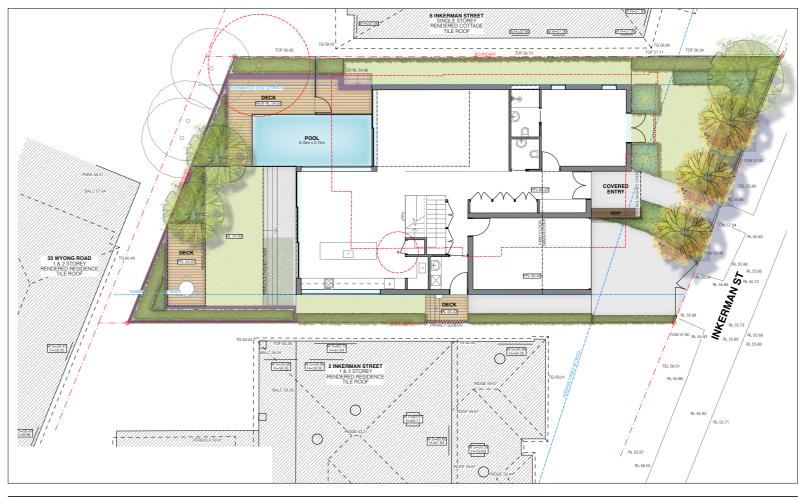

SITE PLAN - N.T.S





Paterson Design Studio Landscape Architects / Urban Designers	Registered Landscape Architect: Garth Paterson FAILA Reg#716 BLA (CANB) MLAUD (HARV)
Paterson Design Studio PTY. LTD 16a/1-15 Tramore Place Killarney Heights, NSW 2087.	T +61 2 9452 4911 admin@pdsdesign.com.au www.pdsdesign.com.au
Copyright by PDS Pty Ltd. This drawing, or parts thereof, may not be reproduced	

NOTES.
DRAWINGS PRODUCED AND PRINTED COLOUR

<i>'</i> .	DESCRIPTION.	DWN.	CHK.	DATE
	Development Application Landscape Plan	FA	GP	27/05/
	DA Landscape Plan Amendments	DC	GP	01/06/
	DA Landscape Plan Amendments	DC	GP	24/06/

OJECT INKERMAN STREET, MOSMAN NSW 2088	CLIENT. JEHAN THIND &	ARCHITECT. ROTH ARCHITECTS	DWN. DC	CHK. GP	
	LAURA PARK		DATE. 24/0	06/21	
		DRAWING TITLE. LA-000 Cover sheet	SHEET. A3		REVISION. C
			SCALE.		PROJECT NO.

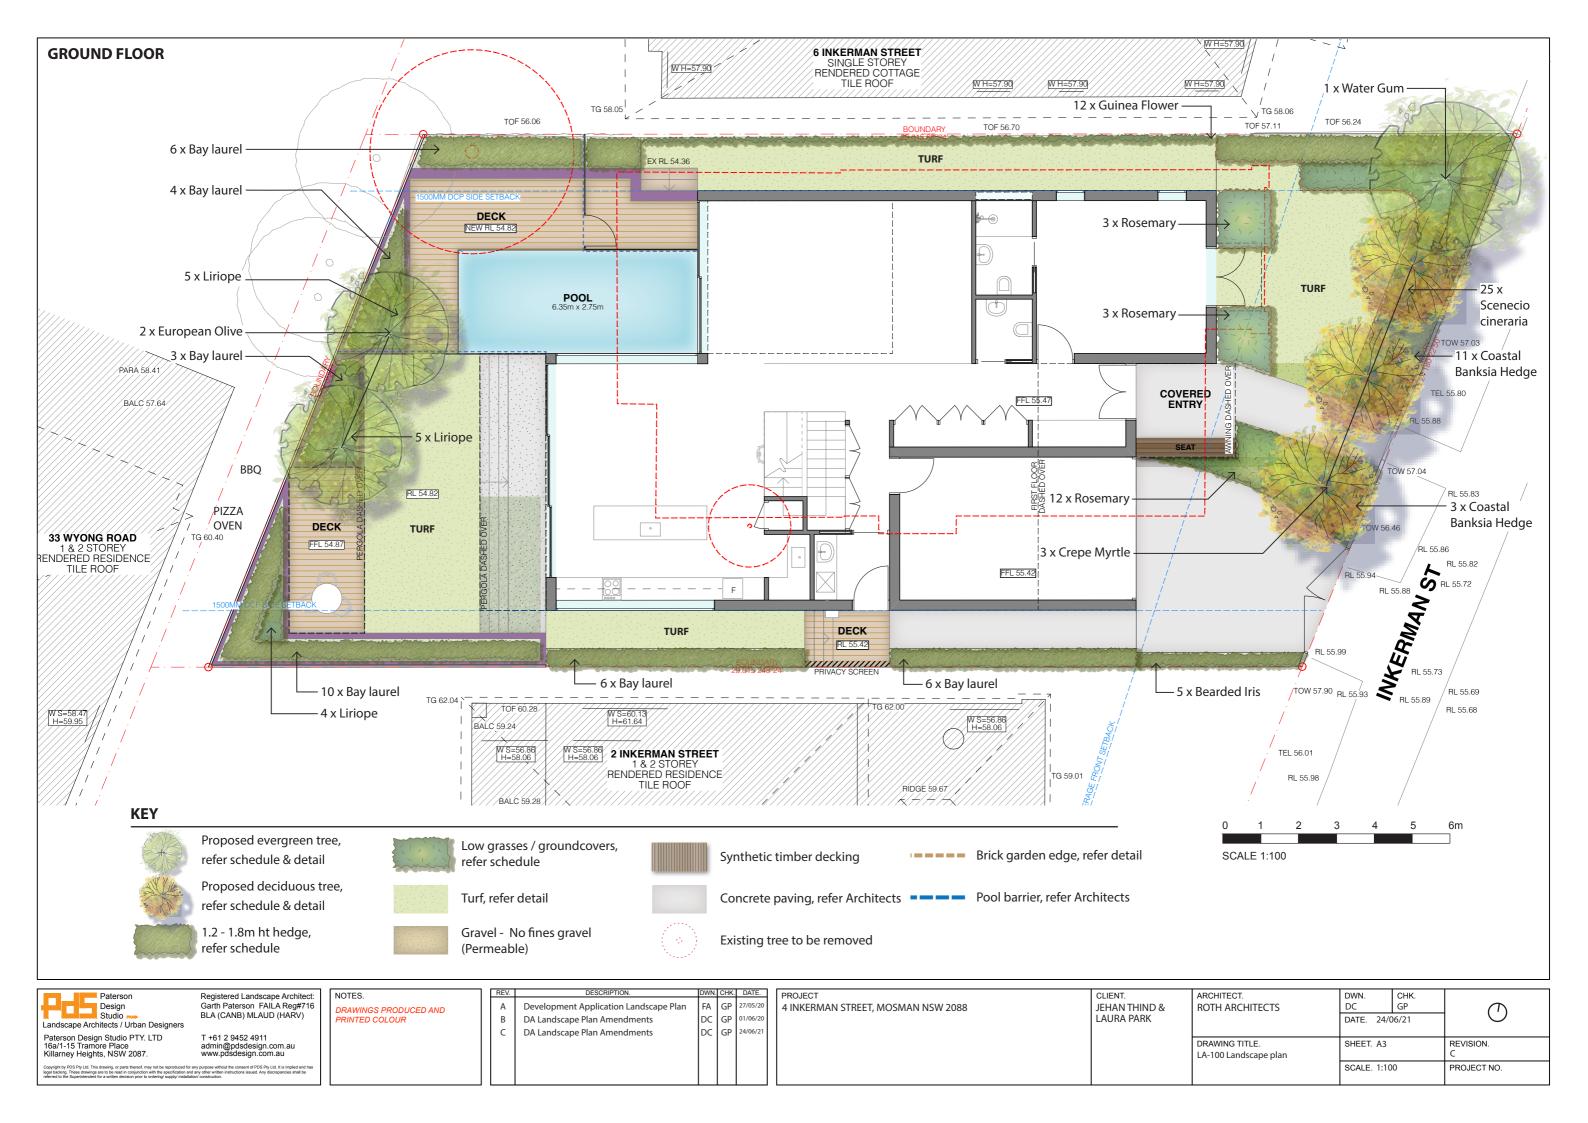

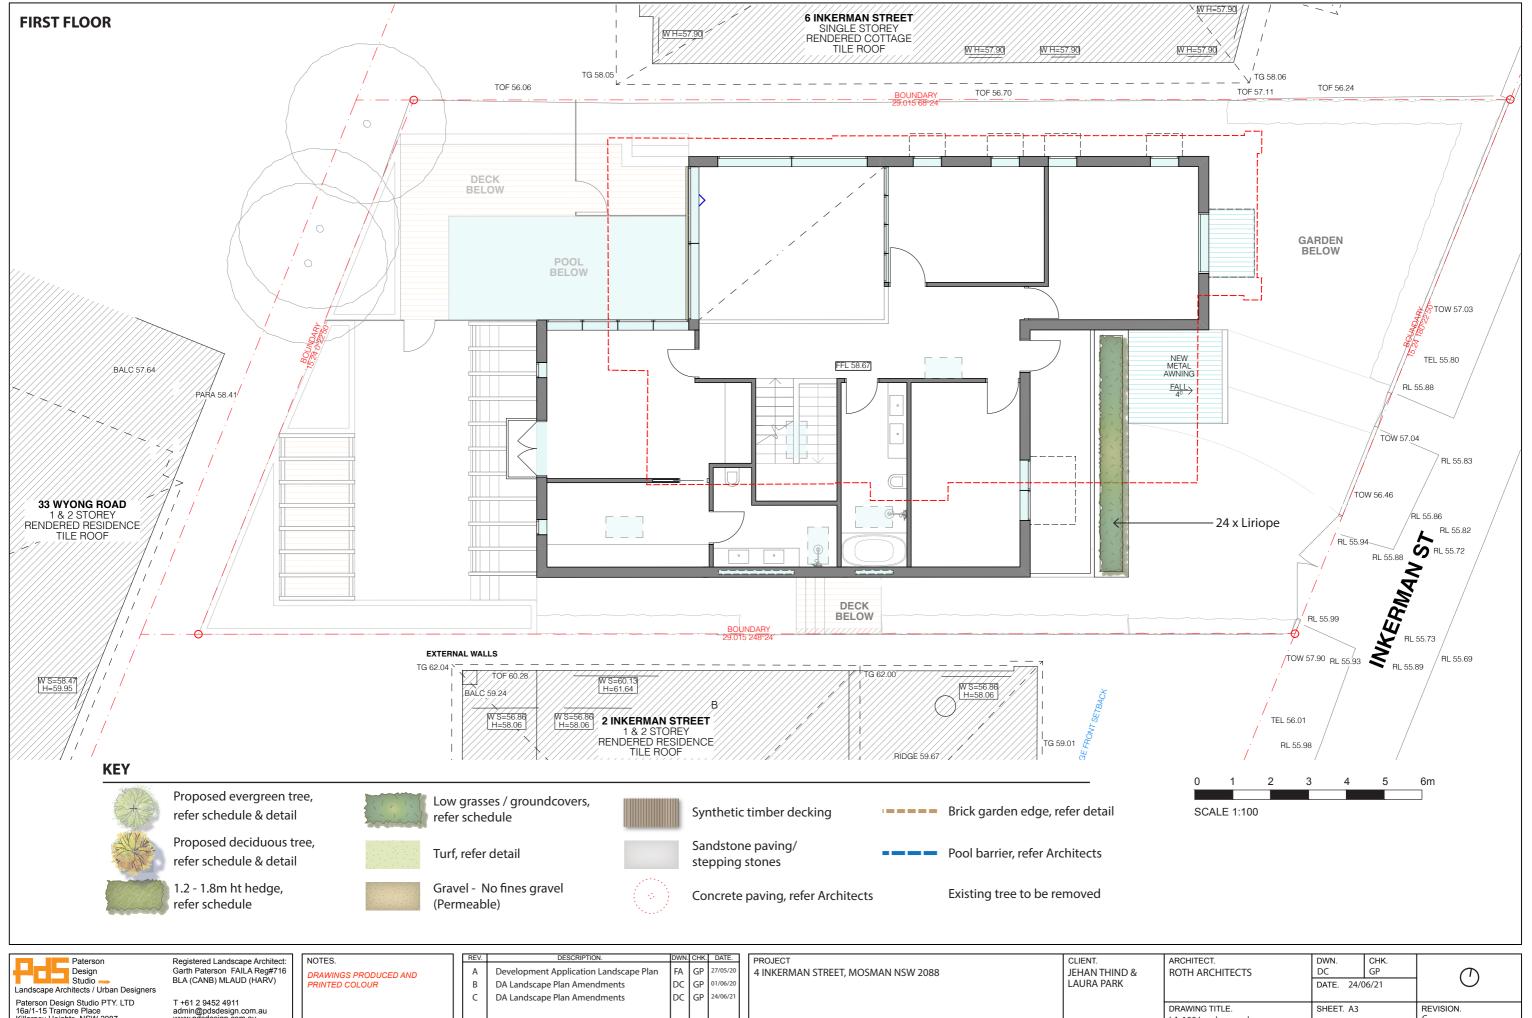


Paterson Design Studio PTY. LTD 16a/1-15 Tramore Place Killarney Heights, NSW 2087.


T +61 2 9452 4911 admin@pdsdesign.com.au www.pdsdesign.com.au

I	REV.	DESCRIPTION.	DWN.	CHK.	DATE
	Α	Development Application Landscape Plan	FA	GP	27/05/
	В	DA Landscape Plan Amendments	DC	GP	01/06/
	С	DA Landscape Plan Amendments	DC	GP	24/06/

ROJECT INKERMAN STREET, MOSMAN NSW 2088	JEHAN THIND & LAURA PARK	ROTH ARCHITECTS	DWN. DC DATE. 24/	GP '06/21	0	
		DRAWING TITLE. LA-100 Landscape plan	SHEET. A3		REVISION. C	
			SCALE. 1:1	00	PROJECT NO.	ĺ

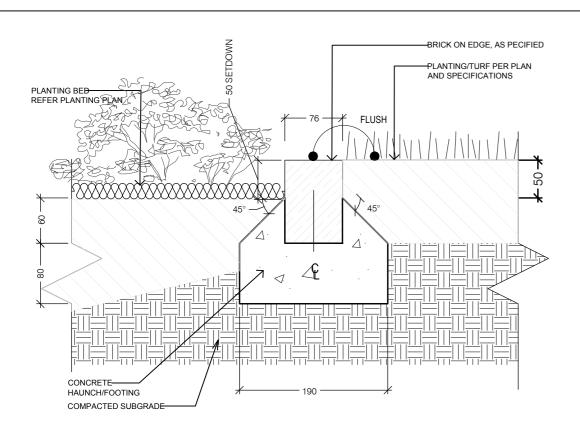

TYPICAL BRICK EDGER DETAIL - scale 1:5

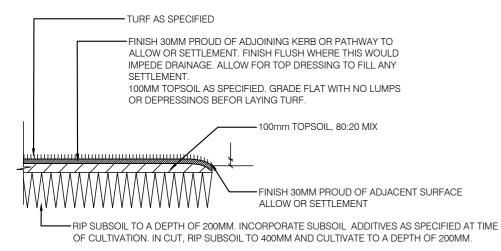


NOT

ENSURE GROUND IS FREE FROM ANY CONTAMINATED MATERIALS DETRIMENTAL TO PLANT GROWTH. PREVENT COMPACTION BY CONSTRUCTION PLANT.

COMPACT LIGHTLY AND UNIFORMLY IN 100MM LAYERS, TO PROVIDE A FINISHED SURFACE AT DESIGN LEVELS, SMOOTH AND FREE OF STONES OR LUMPS OF SOIL AND GRADED TO DRAIN FREELY WITHOUT PONDING TO CATCHMENTS POINTS.

SITE PREPARATION TURF - NTS

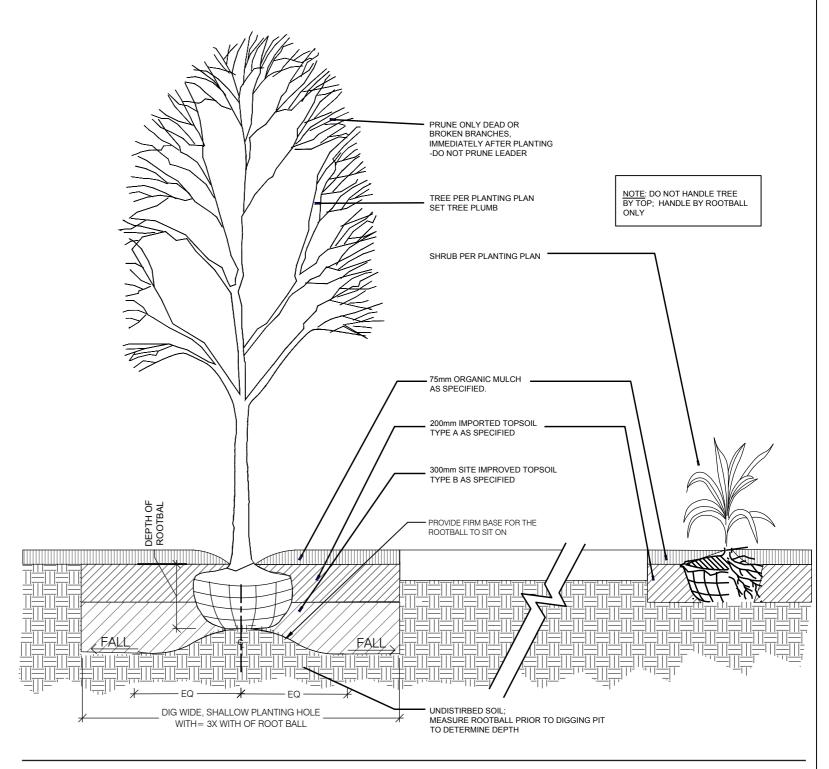

TREE AND SHRUB PLANTING - scale 1:20



Registered Landscape Architect: Garth Paterson FAILA Reg#716 BLA (CANB) MLAUD (HARV)

T +61 2 9452 4911 admin@pdsdesign.com.au www.pdsdesign.com.au

www.pdsdesign.com.au

def or any purpose without the consent of PDS Pty Ltd. It is implied and has

DRAWINGS PRODUCED AND PRINTED COLOUR

REV.	DESCRIPTION.	DWN.	CHK.	DATE.
Α	Development Application Landscape Plan	FA	GP	27/05/20
В	DA Landscape Plan Amendments	DC	GP	01/06/20
C	DA Landscape Plan Amendments	DC	GP	24/06/21

PROJECT 4 INKERMAN STREET, MOSMAN NSW 2088	CLIENT. JEHAN THIND & LAURA PARK	ARCHITECT. ROTH ARCHITECTS	DWN. CHK. DC GP DATE. 24/06/21		
		DRAWING TITLE. LA-200 Landscape details	SHEET. A3		REVISION. C
			SCALE.		PROJECT NO.

									I				
Code	Botanical Name	Common Name	Images	Height	Spread	Description	Seasonal/ Special Feature	Preferred Soil Conditions	Drought/Frost Tolerance	Pest & Disease Susceptibility	Maintenance Requirement	Longevity/ Growth Rate	Native / Exotic
EVERGR	EEN & DECI	DUOUS TRE	ES										
Ole eur	Olea europaea	Common Olive		5 - 15 m	6 m	Naturally found from Northern Africa to south- ern Europe and the Mediterra- nean region, extending to the Arabian Peninsula and southern Asia.	It grows in semi-arid to warm temperate regions in dry forests and scru- bland or coastal limestone slopes from sea level to an altitude from 700m up to 3,000m	It tolerates a wide range of soils but prefers a very well drained, poor to moderately fertile calcar- eous based sandy-stony to loamy soil	It grows in an open to ex- posed hot sunny position toler- ating drought, pollution and light frost.	Black & soft brown scale, olive lace bug, re-shoots after fire (coppice shoot)	It has a low water requirement once established (Scale: 1-drop from 3) preferring organic rich moist to dry soil and will tolerate prolonged dry periods.	Slow	Exotic
Tri lau	Tristianiopsis laurina	Water Gum		12m	8m	Small compact tree with light smooth bark and yellow flowers in Spring.	Dull green dense foliage, small yellow flowers during Novem- ber to January.	Prefers moist fertile soils with good mois- ture levels in summer. Adapt- able to a wide range of soil conditions.	Tolerant of low temperatures to minus 3°C. Prefers a sheltered spot.	No known susceptibility to any specific pests or diseases.	Regular watering during establishment. May require formative prun- ing to ensure development of a single trunk.	Fast	Native
Lag ind	Lagerstroemia indica x fauriei 'Natchez'	Crepe Myrtle		8m	6m	Smooth greyish trunk and spreading branches. Dark green foliage, produces clusters of white flowers during summer	White flowers from early January to April. Mid green foliage turning yellow, orange & scarlet in Autumn.	Moderately heavy clays & moist but well-drained alluvial soils.	Tolerant of light frosts to minus 3°C.	Susceptible to powdery mil- dew in high humidity.	Regular watering during establishment. Requires formative pruning to ensure development of a single trunk.	Long-lived – 50 years plus in urban areas. Moderate.	Exotic
HEDGE /	CLIMBERS			•									
Ban int	Banksia Integrifolia	Coastal Banksia		15-25m	5m	A gnarled trunk and a windswept appearance and forms a narrow rounded crown. It has dark green leathery leaves that are silvery underneath.	Yellow bottle brush-like flowers appear in early spring	It prefers a well drained moderately fertile sandy soil	Prefers an open sunny position tolerating drought, frost and salt laden winds.	Susceptible to web-covering borer, banksia longicorn, doubleheaded hawk moth, leaf spot.	It has a low water requirement once established, responding to mulch and an occasional deep watering during dry periods when young.	Medium	Native
Hib sca	Hibbertia scandens	Climbing Guinea Flower, Guinea Gold or Snake Vine		2-3m	2.5m+	twinning woody stems that scramble to form a dense cover. Dark glossy green leathery oval leaves and the large yellow wheel-shaped flowers	Large yellow wheel-shaped flowers appear solitary during spring or throughout the year in warm regions.	Well drained, moist sandy to clay loam, organic rich acidic	Salt-spray tolerant, drought tolerant, frost tender	Plague thrips, phytophthora root rot, grey mold, grapevine moth	It is used as a ground cover and as a spill-over in rockeries. Cut back after flowering	Fast	Native
Lau nob	Laurus nobilis	Bay laurel		5-6 m	4 m	This shrub to small tree has ascending branches that form a compact conical crown	It has glossy dark green aromatic elliptical leaves and the small yellow flowers appear in a clus- ter during spring and are followed by purplvish black berries	Well drained clay to sandy loam, realiable moist, fertile	Full sun to semi- shade, light frost tolerant, pollu- tion, drought, wind protection	White and pink wax scale, laurel psyllid, red and cottonycushion scale	Medium water use	Medium	Exotic

Paterson
Design
Studio
Landscape Architects / Urban Designers
Paterson Design Studio PTY. LTD
16a/1-15 Tramore Place
Killarney Heights, NSW 2087.

Registered Landscape Architect: Garth Paterson FAILA Reg#716 BLA (CANB) MLAUD (HARV)

T +61 2 9452 4911 admin@pdsdesign.com.au www.pdsdesign.com.au

DRAWINGS PRODUCED AND PRINTED COLOUR	

NOTES.

REV.	DESCRIPTION.	DWN.	CHK.	DATE.	11	PRC
Α	Development Application Landscape Plan	FA	GP	27/05/20	П	4 IN
В	DA Landscape Plan Amendments	DC	GP	01/06/20	П	
C	DA Landscape Plan Amendments	DC	GP	24/06/21	П	
					П	
					П	
					П	

PROJECT 4 INKERMAN STREET, MOSMAN NSW 2088	LAURA PARK	ARCHITECT. ROTH ARCHITECTS	DWN. CHK. DC GP DATE. 24/06/21		
		DRAWING TITLE. LA-300 Planting schedule	SHEET. A3		REVISION. C
			SCALE.		PROJECT NO.

LOW SHRUBS | GROUNDCOVERS

	MODO GINO		-										
Lir mus	Liriope muscari	Lily Turf, Big Blue lilyturf		0.3 - 0.45 m	0.5 m	This tuberous perennial has a tufted habit with upright dark green strap-like leaves.	The small violet-mauve cup-shaped flowers appear in a raceme above the foliage from mid to late summer.	Well drained fer- tile sandy-clay loam, moist.	Semi-shade, moderately drought and frost-cold tolerant, wind protection	Slugs and snails cause damage on young plants	Establish clumps require little maintenance and have a medium water requirement once established.	Medium	Exotic
lri ger	Iris germanica	Bearded Iris		0.6 - 1 m	0.5 m	It is naturally found in Europe where it is a natural hybrid between Iris pallida and Iris variegata.	The German Iris is grown for its flowers and clumping habit.	It prefers a well drained fertile organic rich moist sandy to clay loam with a pH range from 6.0 to 7.0.	It grows in a wind protected semi shaded to sunny position and is frost tolerant but drought tender and dislikes wet soils.	Leaf spot, aphids, rust, leaf scorch, soft & rhizome rot, thrips, borers	Once established it has a high water requirement (Scale: 3-drops from 3), responding to reliable soil moisture.	Fast	Exotic
Sal ros	Salvia rosmarinus	Rosemary		1.5-2 m	4 m	Is naturally found in the western and central Mediterranean region from Turkey to Spain, southern France and Italy.	It has small light grey-green leaves and the purple 2-lipped flowers appear abundantly towards the end of the branches from spring to summer.	Well drained moderately fertile moist-dry sandy-stony soil	Full sun to semi shade, exposed position, salt, drought and frost resistant	Phytophthora root rot, crown rot	It has a low water requirement once established.	Fast	Native
Sen cin	Senecio cineraria	Dusty Miller		0.4 - 1 m	0.6 m	Is naturally found in the western and central Mediterranean region from Turkey to Spain, southern France and Italy.	The Silver Ragwort is commonly grown for its foliage, whitish stems and its yellow flower heads.	It prefers a moderately fertile well drained sandystony to clay loam that is reliable moist with a pH range from 5.5 to 7.5 and tolerates chalky soil.	It grows in an open sunny position and is slightly frost and drought tolerant once established.	Susceptible to rust, white flys, grey mould, downy & powdery mildew	Once established it has a low water requirement (Scale: 1-drop from 3) and in cold regions it is commonly used as an annual.	Medium	Exotic

Paterson
Design
Studio Research Architects / Urban Designers
Paterson Design Studio PTY. LTD
16a/1-15 Tramore Place
Killarney Heights, NSW 2087.

Registered Landscape Architect: Garth Paterson FAILA Reg#716 BLA (CANB) MLAUD (HARV)

T +61 2 9452 4911 admin@pdsdesign.com.au www.pdsdesign.com.au

right by PDS Ply Ltd. This drawing, or parts thereof, may not be reproduced for any purpose without the consent of PDS Ply Ltd. It is implied and backing. These drawings are to be read in conjunction with the specification and any other written instructions issued. Any discrepances shall be

IOTES.	
PRAWINGS PRODUCED AND PRINTED COLOUR	

V.	DESCRIPTION.	DWN.	CHK.	DATE.	PROJE
	Development Application Landscape Plan	FA	GP	27/05/20	4 INKI
	DA Landscape Plan Amendments	DC	GP	01/06/20	
:	DA Landscape Plan Amendments	DC	GP	24/06/21	

OJECT NKERMAN STREET, MOSMAN NSW 2088	CLIENT. JEHAN THIND &	ARCHITECT. ROTH ARCHITECTS	DWN. DC	CHK. GP				
	LAURA PARK		DATE. 24/0	06/21				
		DRAWING TITLE. LA-301 Planting schedule	SHEET. A3		REVISION. C			
			SCALE.		PROJECT NO.			